

DEPARTMENT OF THE ARMY PERMIT

Permittee: Albany Port District Commission
Attention: Mr. Richard Hendrick, Chief Executive Officer
106 Smith Boulevard
Albany, New York 12202
(518) 463-2164

Permit Number: NAN-2021-00948-UDA

Date Issued: APR 10 2023

Issuing Office: U.S. Army Corps of Engineers, New York District

NOTE: The term "you" and its derivatives, as used in this permit, means the permittee or any future transferee. The term "this office" refers to the appropriate district or division office of the Corps of Engineers having jurisdiction over the permitted activity or the appropriate official of that office acting under the authority of the commanding officer.

You are authorized to perform work in accordance with the terms and conditions specified below.

Project Description: Dredging, with 10-years maintenance, of approximately 80,000 cubic yards (cy) of material via a barge-mounted crane with a closed clamshell bucket, from a 2.62-acre area of riverbed to a depth of 32 feet (ft) below the plane of the mean low water (MLW) with 2 ft over dredge to 34 ft. MLW. Double-walled silt curtains will be installed during the entire dredging operation. The dredged material will be placed into scows and will be allowed to settle in the scows before the water is decanted and discharged back into the Hudson River. Once the material has been decanted, the scows will be shipped via tug to the Clean Earth Clermont Dredged Processing Facility (Facility I.D. 215.734.1400), located at One Linden Avenue East, Jersey City, New Jersey for amendment and trucking to an upland disposal site.

A new wharf, 500 ft long by 93 ft wide, will be constructed along the west bank of the Hudson River. The wharf will consist of a heavy stone slope revetment, a high-modulus steel sheet pile cutoff wall, and a drilled shaft supported open wharf and relieving platform. Structures and fill installed below mean high high water elevation include 136, 48-inch diameter drilled shaft foundations with permanent steel casing, and approximately 1,162 CY of rip rap. Approximately 263 CY of the rip rap would be placed below mean high water elevation. The permanent steel casing for the drilled shaft foundations and the sheet pile wall components will be vibrated in, rather than utilizing an impact hammer. An impact hammer will only be used to seat the steel casing within the first few inches in the top of rock.

A new, 3-span bridge will be constructed over the Normans Kill channel. The bridge will be constructed on two (2) reinforced concrete drilled shafts. The construction of the northern shaft will require the discharge of fill material into 0.04-acre of wetland.

Five new warehouse and manufacturing buildings totaling approximately 626,014 (SF) and associated attendant features including roadways, parking areas, utilities, an approximately 822 linear foot retaining wall, a wastewater treatment facility, stormwater management features and associated treated runoff outfalls to the Hudson River will be constructed. The construction of the warehouse and manufacturing buildings and attendant features will require the discharge of fill material into total of 0.81-acre of wetlands, comprised of approximately 0.30-acre of palustrine emergent wetland and 0.51-acre of palustrine forested wetland, respectively. In addition, a maximum of 0.33-acre of palustrine forested wetland will be permanently converted to an emergent cover type to facilitate the construction of the new buildings and attendant features. An 18-inch diameter water intake pipe and associated screening will be installed within the Hudson River.

To mitigate for unavoidable impacts to waters of the United States, the applicant shall purchase a total of 2.57 credits from the Middle Hudson Service Area of the Ducks Unlimited New York In-Lieu Fee Program, secure a restrictive covenant over 1,700 liner feet of on-site riparian buffer along the Hudson River, and implement a submerged aquatic vegetation transplantation and monitoring effort.

All work shall be performed in accordance with the attached drawings and Special Conditions (A) through (R) listed below, all which are hereby made a part of this permit.

Project Location: IN: Hudson River

AT: City of Albany and Town of Bethlehem, Albany County, New York

Permit Conditions:

General Conditions:

1. The time limit for completing the work authorized ends on April 10, 2033. If you find that you need more time to complete the authorized activity, submit your request for a time extension to this office for consideration at least one month before the above date is reached.
2. You must maintain the activity authorized by this permit in good condition and in conformance with the terms and conditions of this permit. You are not relieved of this requirement if you abandon the permitted activity, although you may make a good faith transfer to a third party in compliance with General Condition 4 below. Should you wish to cease to maintain the authorized activity or should you desire to abandon it without a good faith transfer, you must obtain a modification of this permit from this office, which may require restoration of the area.
3. If you discover any previously unknown historic or archeological remains while accomplishing the activity authorized by this permit, you must immediately notify this office of what you have

found. We will initiate the Federal and state coordination required to determine if the remains warrant a recovery effort or if the site is eligible for listing in the National Register of Historic Places.

4. If you sell the property associated with this permit, you must obtain the signature of the new owner in the space provided and forward a copy of the permit to this office to validate the transfer of this authorization.
5. If a conditioned water quality certification has been issued for your project, you must comply with the conditions specified in the certification as special conditions to this permit. For your convenience, a copy of the certification is attached if it contains such conditions.
6. You must allow representatives from this office to inspect the authorized activity at any time deemed necessary to ensure that it is being or has been accomplished in accordance with the terms and conditions of your permit.

Special Conditions:

- (A) The permittee shall submit to this office the dates of commencement and completion of the herein authorized activities on the attached forms.
- (B) The permittee, and its agents, shall conduct all dredging activities from September 1st through December 31st of any calendar year in order to minimize adverse aquatic impacts to diadromous fish spawning migrations and their peak biological activity, and impacts to Shortnose sturgeon (*Acipenser brevirostrum*) and Atlantic sturgeon (*A. oxyrinchus*).
- (C) The permittee shall install a weighted double-walled silt curtain during dredging operations.
- (D) The permittee shall maintain a copy of this permit on all vessels engaged in dredging and transporting dredged materials.
- (E) The permittee shall undertake all dredging activities in such a manner as to avoid large refuse piles, ridges across the bed of the waterway or deep holes, which have a tendency to cause injury to navigable channels or the banks of the waterway.
- (F) If any portion of the Federal Navigation Channel affected by contractor operations, then it must be restored to its project depth (32' MLLW), with the side slope (1H3V) also restored. In addition, the permittee shall perform hydrographic surveys of the federal navigation channel adjacent to the worksite upon completion of work. The survey shall be submitted to the Regulatory Branch Upstate Regulatory Field Office within 30 days of the completion of the activity authorized by this permit verification.

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(G) The permittee shall, no less than fourteen (14) days prior to the commencement of any dredging, notify the United States Coast Guard office (USCG) of the commencement of any dredging and expected completion date, the hours of the day the work will be performed, the names of the vessels on-scene, the VHF radio channel(s) the vessels will monitor, and the project's 24/7 point(s) of contact. This information may be emailed to SECTORNYWWM@uscg.mil.

(H) No less than 14 days prior to the commencement of any in-water work, the permittee shall inform local waterway users of the commencement of the work, using the "Local Notice to Mariners." Information required to be provided in the Local Notice to Mariners can be found at <http://www.navcen.uscg.gov>. This information may be e-mailed to D01-SMB-LNM@uscg.mil.

(I) The permittee shall provide the National Oceanic and Atmospheric Administration National Ocean Service (NOAA-NOS) of the project's physical completion date and as-built specifications so that NOAA may initiate the appropriate navigation chart updates and corrections. This information must be submitted online at:

<http://ocsdata.ncd.noaa.gov/idrs/discrepancy.aspx>

(J) The permittee shall verify, in writing, compliance with all required notices to USCG and NOAA-NOS as called for above, within five (5) calendar days of each notice. Verifications shall include the permit number (NAN-2021-00948-UDA) and be delivered to the New York District by email at cenan.rfo@usace.army.mil (preferred) or to the following address:

DEPARTMENT OF THE ARMY
US Army Corps of Engineers
ATTN: CENAN-OP-RU
Upstate New York Section
1 Buffington St., Bldg. 10, 3rd Fl. North
Watervliet, New York 12189-4000

(K) The permittee understands and agrees that, if future operations by the United States require the removal, relocation, or other alteration, of the structure or work herein authorized, or if, in the opinion of the Secretary of the Army or his authorized representative, said structure or work shall cause unreasonable obstruction to the free navigation of the navigable waters, the permittee will be required, upon due notice from the Corps of Engineers, to remove, relocate, or alter the structural work or obstructions caused thereby, without expense to the United States. No claim shall be made against the United States on account of any such removal or alteration.

(L) Outdoor lighting shall be located or shielded so that it is not confused with any aids to navigation and does not interfere with navigation on the adjacent waterway.

(M) The permittee shall ensure The Federal Navigation Channel will remain clear of any barges, vessels, and/or floating equipment. Any equipment staged within the channel must be temporary, and their placement will be coordinated with the USACE Albany Field Office and USCG.

(N) Within sixty (60) days of the effective date of this permit, the permittee shall submit to the New York District, U.S Army Corps of Engineers and the National Oceanic and Atmospheric Administration National Marine Fisheries, a final version of the document entitled "Port of Albany Compensatory SAV Mitigation Plan - Draft", dated January 9, 2023, and prepared AKRF, Inc., for review and approval. The mitigation measures outline in the draft plan shall not be implemented until approved in writing by the U.S. Army Corps of Engineers. No dredging associated with the project shall be conducted until the mitigation plan has been approved in writing, and the 0.21-acre of SAV has been transplanted in accordance with the plan.

(O) The permittee shall accomplish compensatory mitigation through the purchase of 2.57 credits from the Middle Hudson Service Area of the Ducks Unlimited New York In-Lieu Fee Program (HUC 02020006 & ~35 square mile section of HUC 01100005). Within thirty (30) days of the effective date of this permit, the permittee shall supply this office with a copy of the signed Credit Sale Letter verifying acceptance of full payment by Ducks Unlimited New York In-Lieu Fee Program for the appropriate credits.

(P) The permittee shall secure restrictive covenants on the 2.87-acre riparian buffer to guarantee their preservation for wetland and wildlife resources. Within thirty (30) days from the effective date of this permit, the permittee shall accomplish the preservation of these areas by properly executing and filing the restrictive covenant, as described in the draft received by this office on July 5, 2022, with the Recorder of Deeds for Albany County and shall provide to this office a copy of the documents, as filed in County records, within thirty (30) days of its filing.

(Q) Within sixty (60) days of the effective date of this permit, the permittee shall submit the final dredge plan to this office for review and written approval.

(R) The permittee shall undertake the authorized filling activities in a manner aimed at reducing impacts upon the general environment. In addition, the permittee shall not stockpile fill or other materials in a manner conducive to erosion, or in areas likely to cause high turbidity runoff during storm events. All exposed soils shall be re-vegetated in a timely manner to further reduce potential effects. The permittee shall also fence off all wetlands and other sensitive ecological areas during construction periods to prevent equipment and personnel from entering these areas.

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(S) The permittee shall ensure that all synthetic erosion control features (e.g., silt fencing, netting, mats), which are intended for temporary use during construction, are completely removed and properly disposed of after their initial purpose has been served. Only natural fiber materials, which will degrade after time, may be used as permanent measures, or if used temporarily, may be abandoned in place.

Further Information:

1. Congressional Authorities: You have been authorized to undertake the activity described above pursuant to:

(X) Section 10 of the Rivers and Harbors Act of 1899 (33 U.S. Code 403).

(X) Section 404 of the Clean Water Act (33 U.S. Code 1344).

() Section 103 of the Marine Protection, Research and Sanctuaries Act of 1972 (33 U.S.C. 1413).

2. Limits of this authorization:

a. This permit does not obviate the need to obtain other Federal, state, or local authorizations required by law.

b. This permit does not grant any property rights or exclusive privileges.

c. This permit does not authorize any injury to the property or rights of others.

d. This permit does not authorize interference with any existing or proposed Federal project.

3. Limits of Federal Liability: In issuing this permit, the Federal Government does not assume any liability for the following:

a. Damages to the permitted project or uses thereof as a result of other permitted or unpermitted activities or from natural causes.

b. Damages to the permitted project or uses thereof as a result of current or future activities undertaken by or on behalf of the United States in the public interest.

c. Damages to persons, property, or to other permitted or unpermitted activities or structures caused by the activity authorized by this permit.

d. Design or construction deficiencies associated with the permitted work.

e. Damage claims associated with any future modification, suspension, or revocation of this permit.

4. Reliance on Applicant's Data: The determination of this office that issuance of this permit is not contrary to the public interest was made in reliance on the information you provided.

5. Reevaluation of Permit Decision: This office may reevaluate its decision on this permit at any time the circumstances warrant. Circumstances that could require a reevaluation include, but are not limited to, the following:

a. You fail to comply with the terms and conditions of this permit.

b. The information provided by you in support of your permit application proves to have been false, incomplete, or inaccurate (See 4 above).

c. Significant new information surfaces which this office did not consider in reaching the original public interest decision.

Such a reevaluation may result in a determination that it is appropriate to use the suspension, modification, and revocation procedures contained in 33 CFR 325.7 or enforcement procedures such as those contained in 33 CFR 326.4 and 326.5. The referenced enforcement procedures provide for the issuance of an administrative order requiring you to comply with the terms and conditions of your permit and for the initiation of legal action where appropriate. You will be required to pay for any corrective measures ordered by this office, and if you fail to comply with such directive, this office may in certain situations (such as those specified in 33 CFR 209.170) accomplish the corrective measures by contract or otherwise and bill you for the cost.

6. Extensions: General Condition 1 establishes a time limit for the completion of the activity authorized by this permit. Unless there are circumstances requiring either a prompt completion of the authorized activity or a reevaluation of the public interest decision, the Corps will normally give favorable consideration to a request for an extension of this time limit.

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PERMIT NO.: NAN-2021-00948-UDA

Your signature below, as permittee, indicates that you accept and agree to comply with the terms and conditions of this permit.

Richard J Hendrick
(PERMITTEE)

April 6, 2023
(DATE)

This permit becomes effective when the Federal official, designated to act for the Secretary of the Army, has signed below.

Stephen R. Bla...
(DISTRICT ENGINEER)

APR 10 2023
(DATE)


For and in behalf of

Matthew W. Luzzatto
Colonel, U.S. Army
Commander and District Engineer

When the structures or work authorized by this permit are still in existence at the time the property is transferred, the terms and conditions of this permit will continue to be binding on the new owner(s) of the property. To validate the transfer of this permit and the associated liabilities associated with compliance with its terms and conditions, have the transferee sign and date below. A copy of the permit signed by the transferee should be sent to this office.

(TRANSFeree)

(DATE)

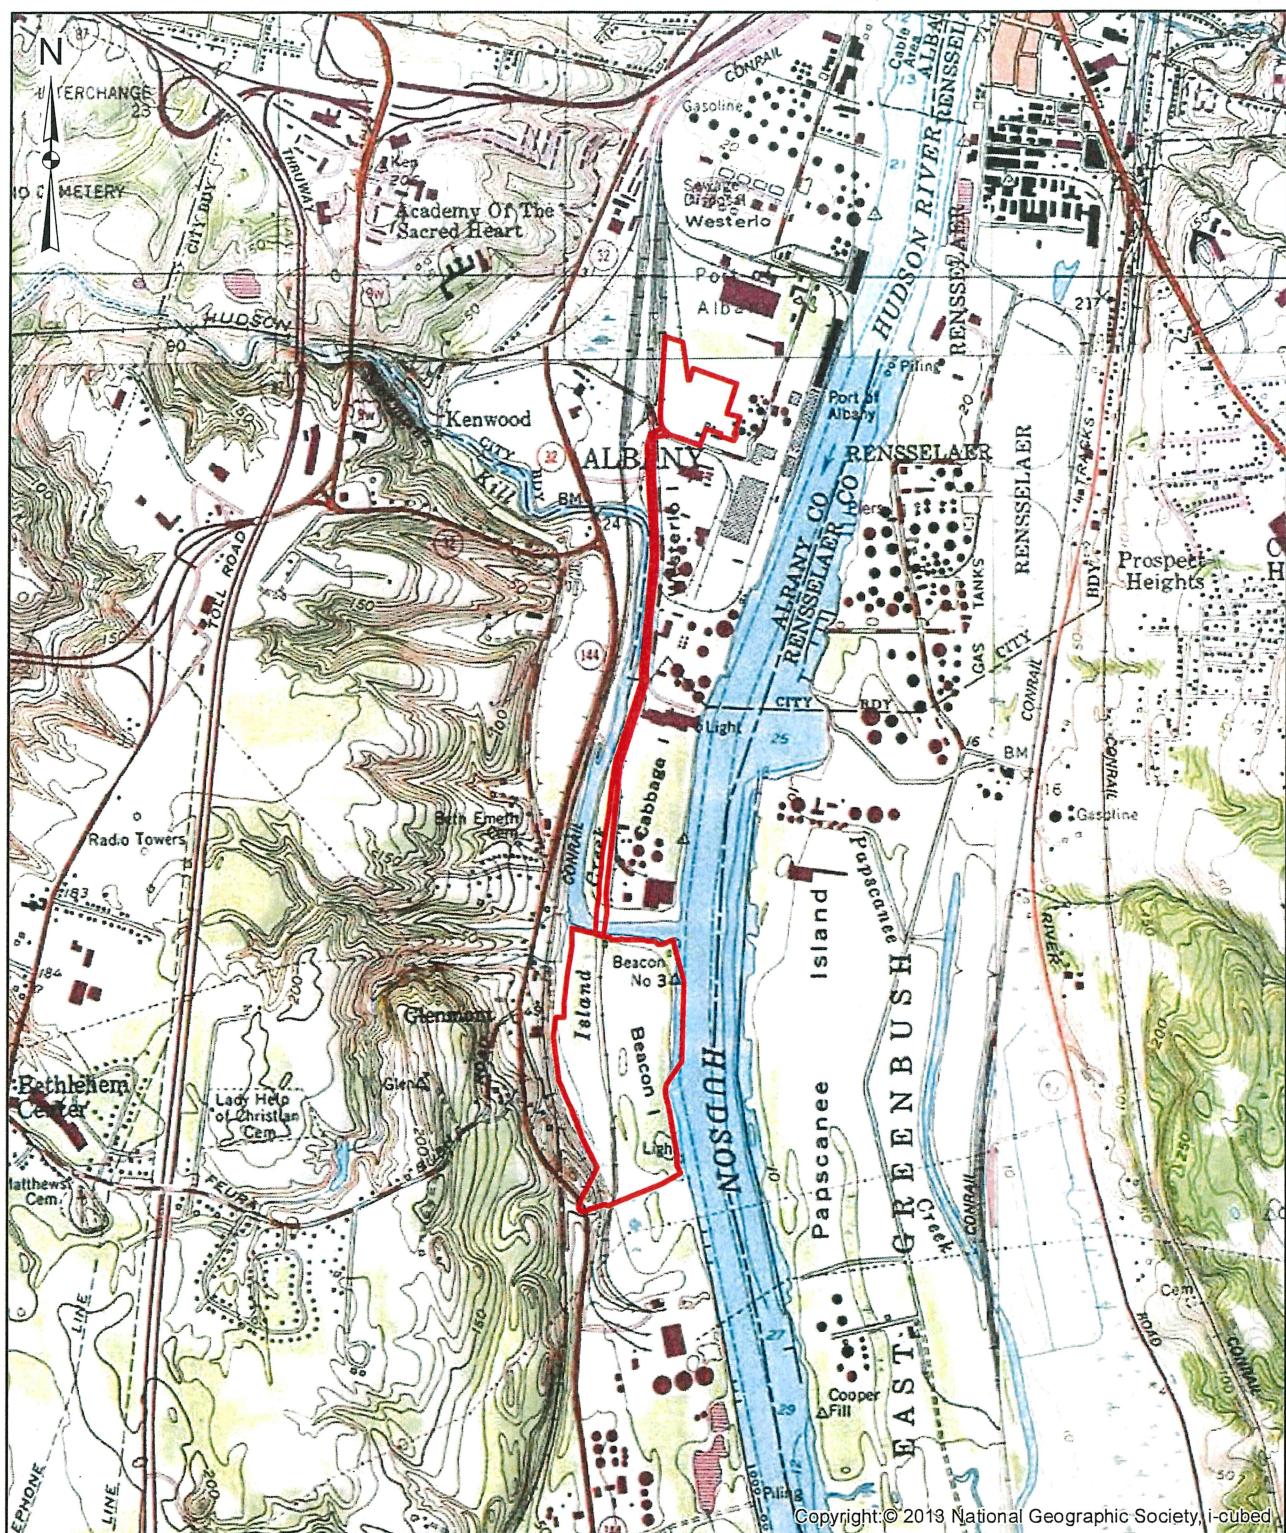

Legend

Project Site

Notes:


- 1) Project boundary is approximate
- 2) All areas are approximate

PORT OF ALBANY DEVELOPMENT
TOWN OF BETHLEHEM, ALBANY COUNTY, NEW YORK

USGS TOPOGRAPHIC MAP

SCALE : AS SHOWN	DATE : JULY 2021	FIGURE : 2-1
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 McFarland Johnson

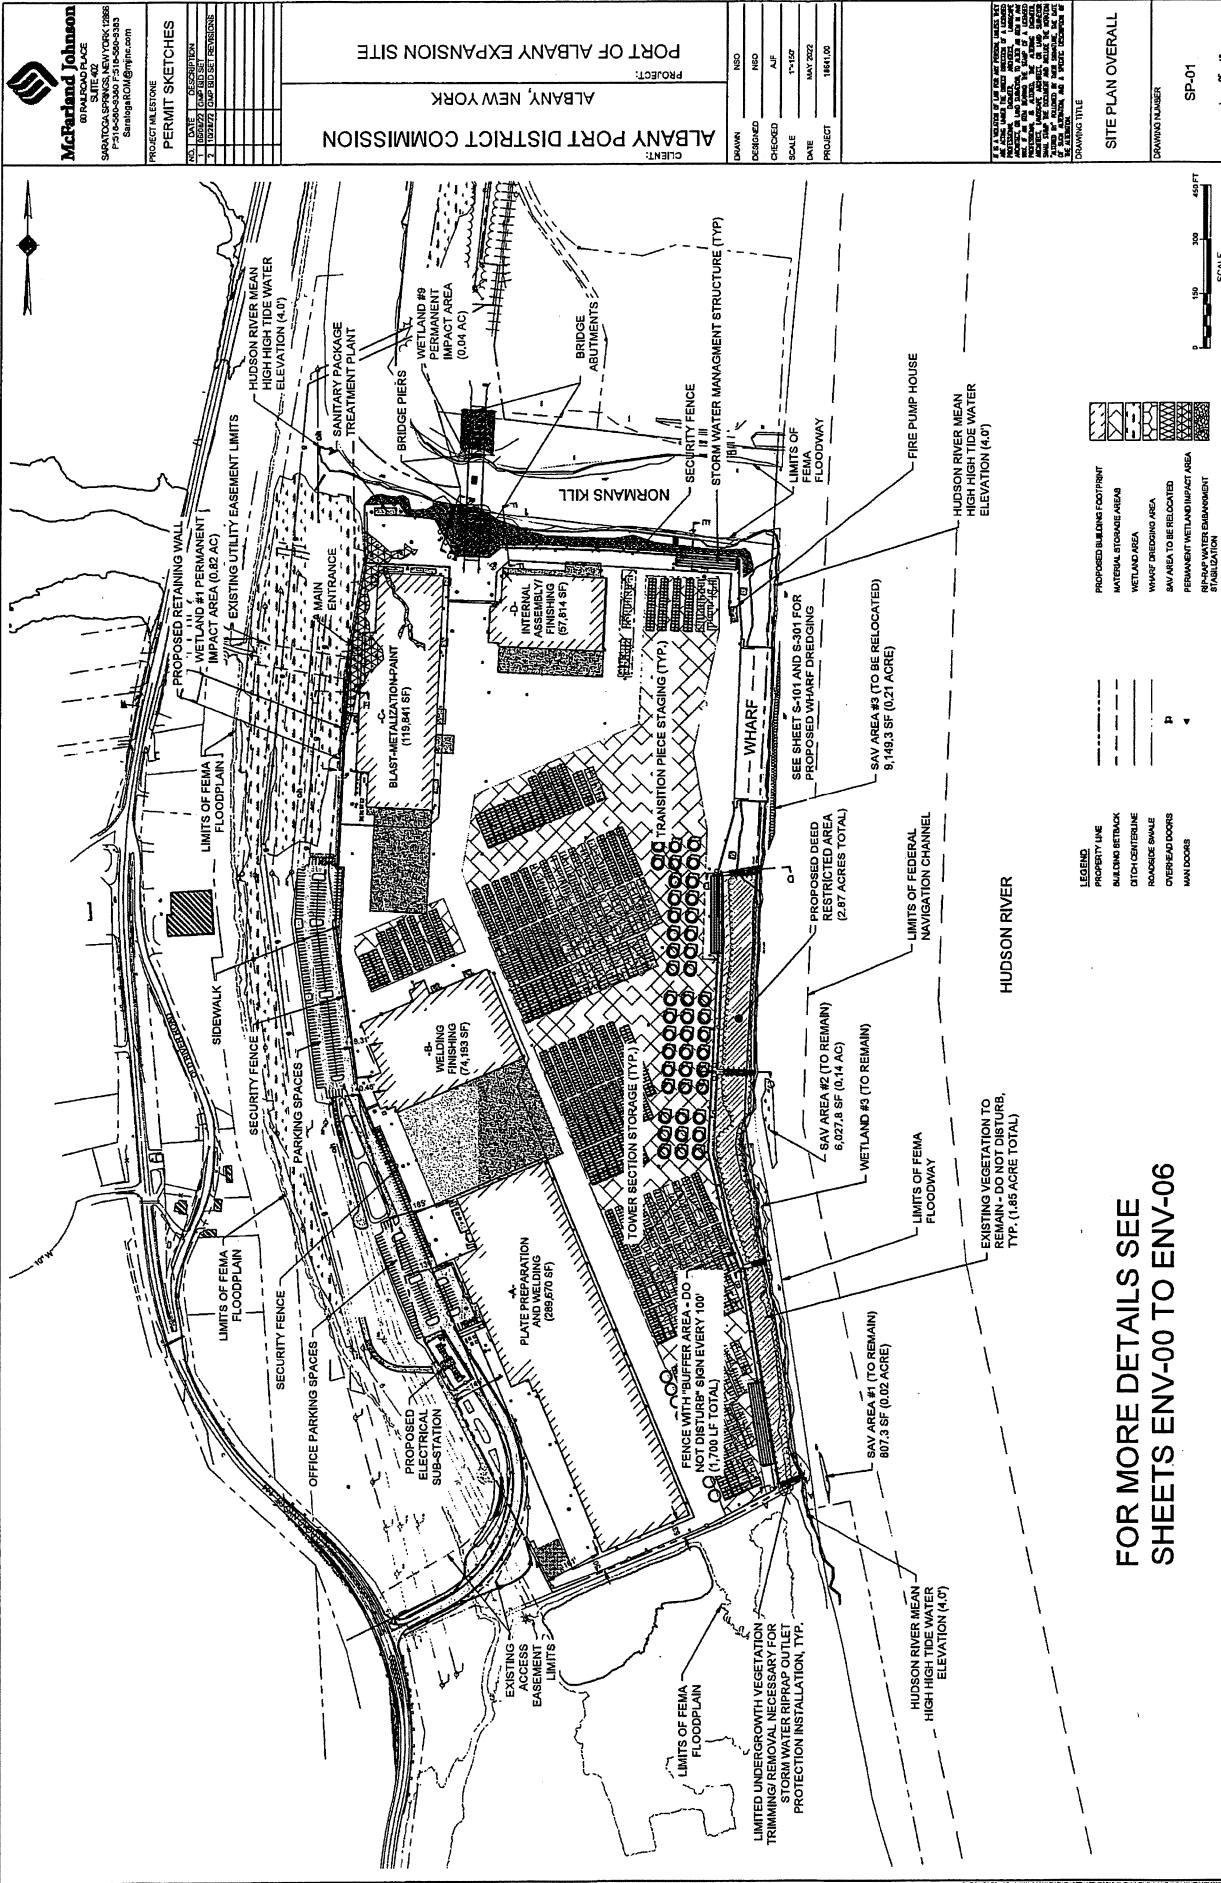

Albany Port District Commission


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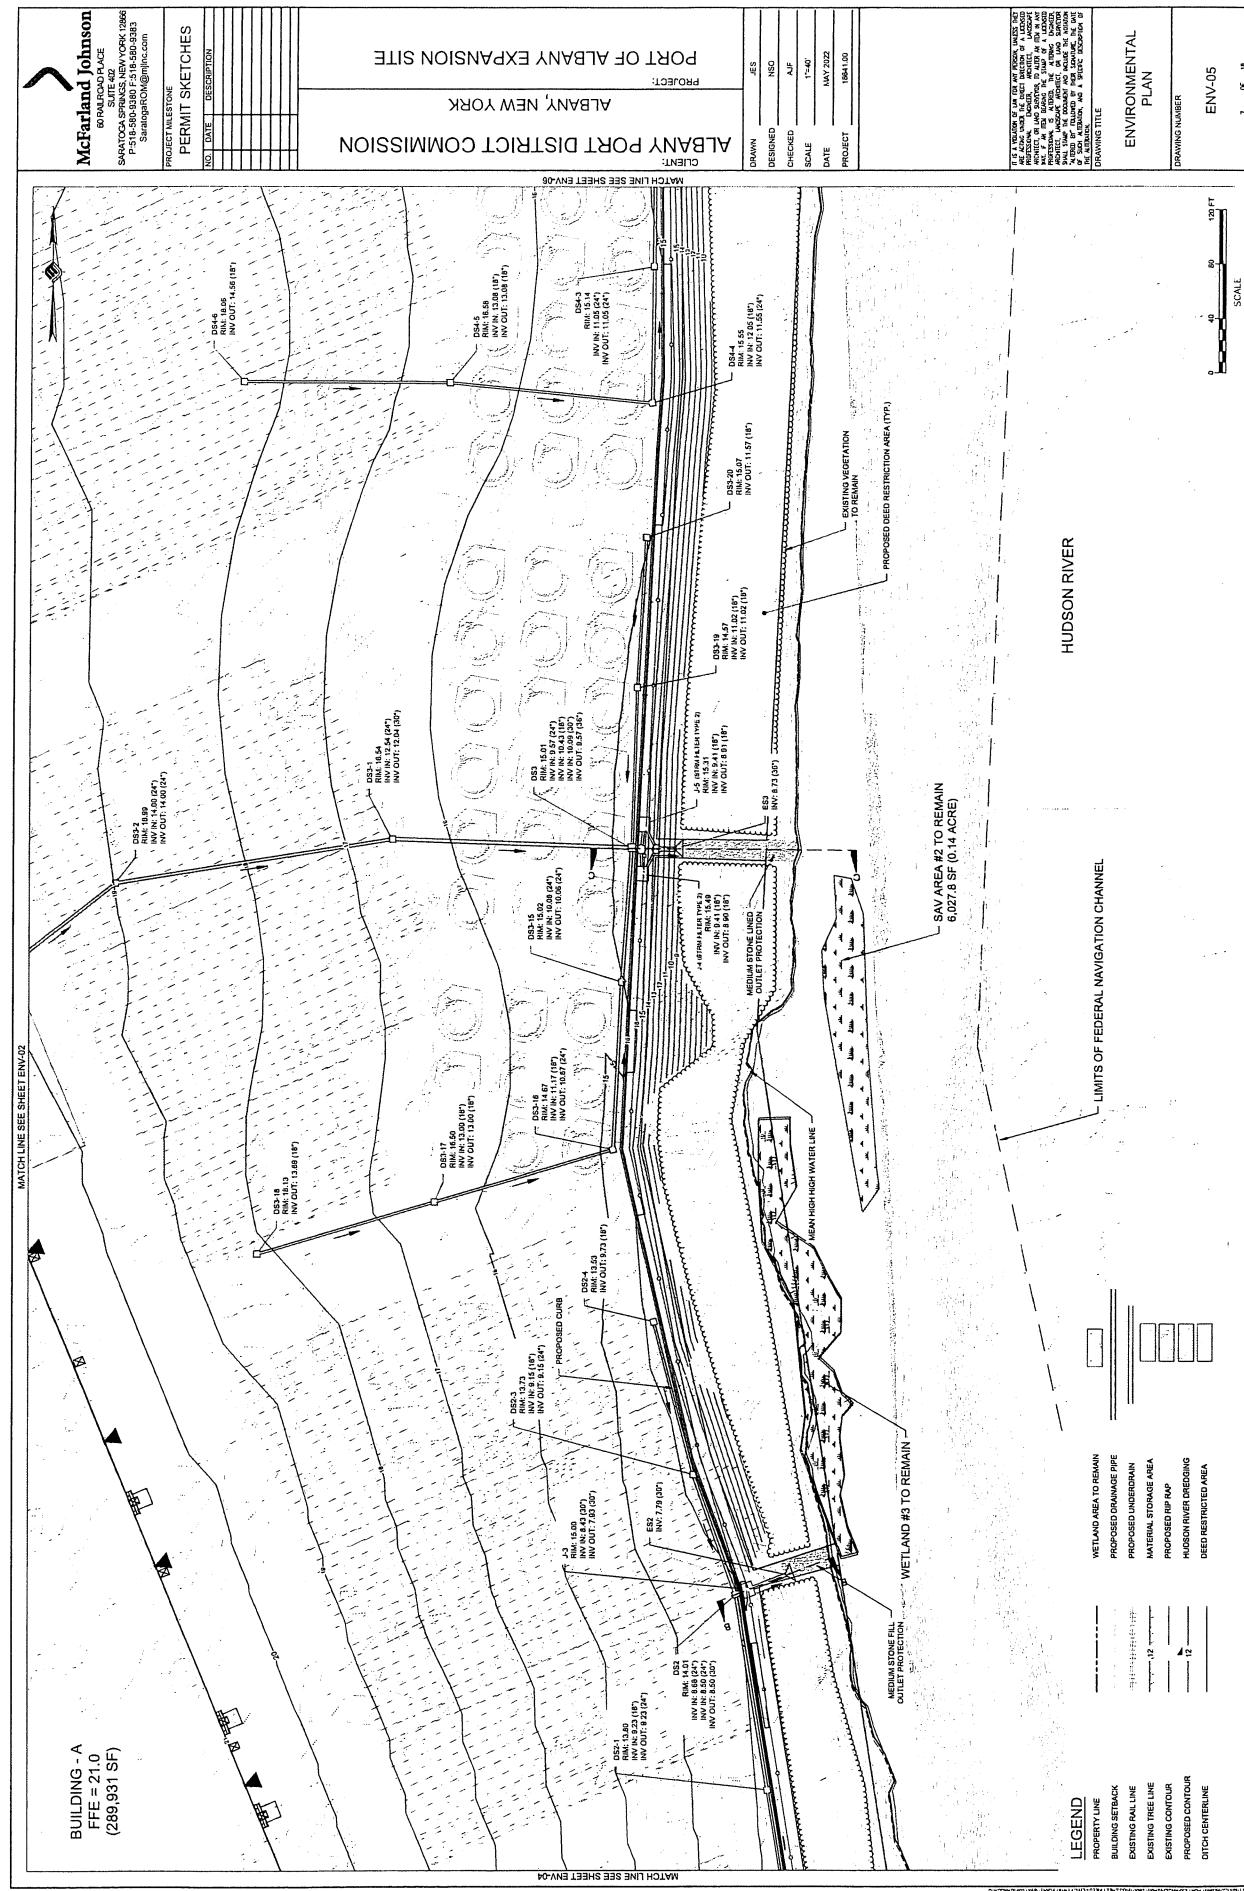
2 of 19

6 of 19

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Albany Port District Commission



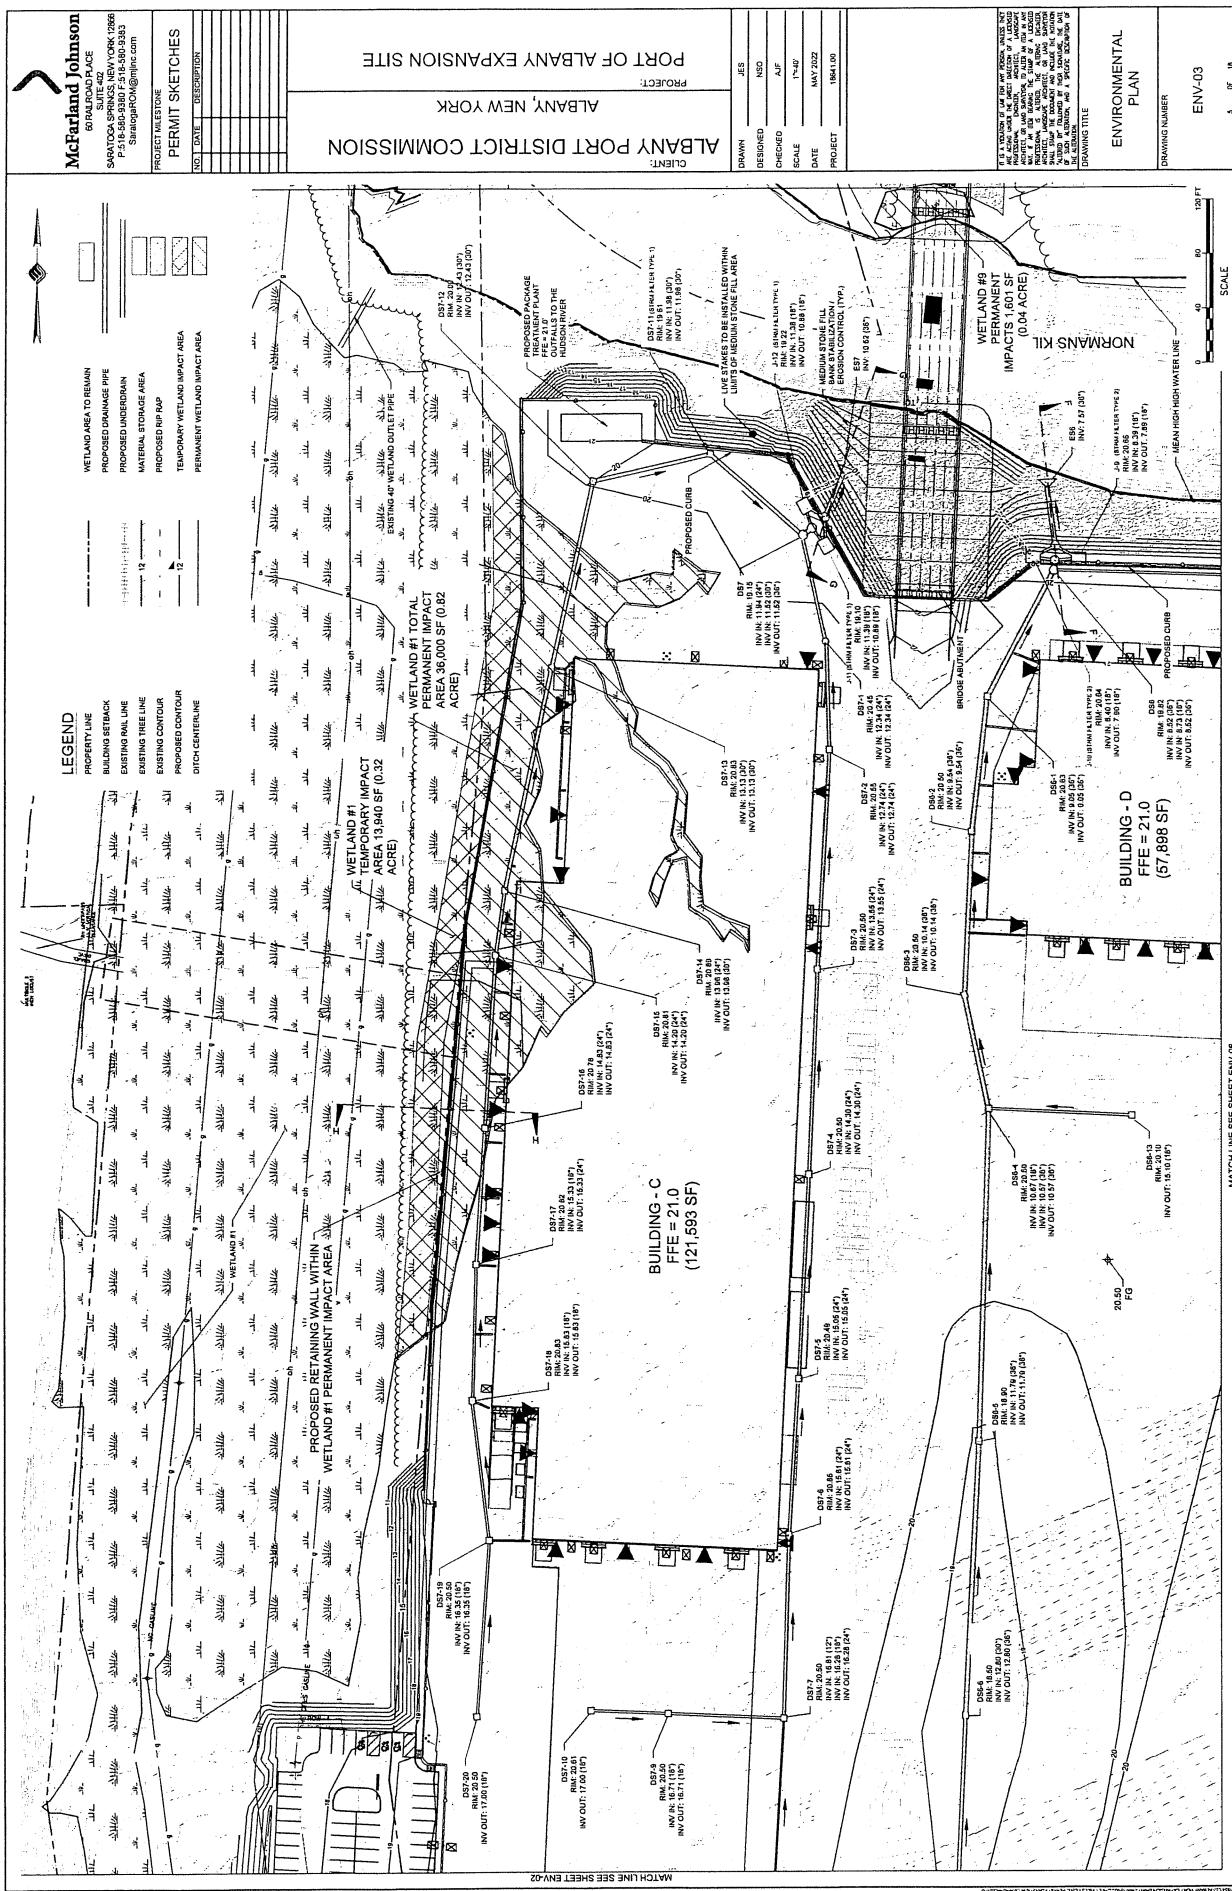

McFarland Johnson
600 N. Wacker Drive
SAGANOGA SPRINGS, NEW YORK 10596
P: 518-540-5330 / F: 518-540-5383
SaganoJohnson@msn.com

PROJECT NUMBER: PORT OF ALBANY EXPANSION SITE
DATE: 07/01/2022

ALBANY PORT DISTRICT COMMISSION
CLERK: ALBANY, NEW YORK

PERMIT SKETCHES

SECTION A-A
Horizontal Scale: 1" = 40'
Vertical Scale: 1" = 10'

SECTION B-B
Horizontal Scale: 1" = 40'
Vertical Scale: 1" = 10'

SECTION C-C
Horizontal Scale: 1" = 40'
Vertical Scale: 1" = 10'

SECTION D-D
Horizontal Scale: 1" = 40'
Vertical Scale: 1" = 10'

SECTION E-E
Horizontal Scale: 1" = 40'
Vertical Scale: 1" = 10'

SECTION F-F
Horizontal Scale: 1" = 40'
Vertical Scale: 1" = 10'

SECTION G-G
Horizontal Scale: 1" = 40'
Vertical Scale: 1" = 10'

SECTION H-H
Horizontal Scale: 1" = 40'
Vertical Scale: 1" = 10'


SECTION I-I
Horizontal Scale: 1" = 40'
Vertical Scale: 1" = 10'


SECTION VIEWS


DRAWING NUMBER: XS-01
DRAWING TITLE: PORT OF ALBANY EXPANSION SITE

NOTES: 1. A COPIED DRAWING OF THE PROJECT NUMBER IS MAILED TO THE PORT OF ALBANY EXPANSION SITE. 2. THIS DRAWING IS FOR INFORMATION PURPOSES ONLY AND IS NOT A CONTRACT DOCUMENT. 3. THIS DRAWING IS FOR INFORMATION PURPOSES ONLY AND IS NOT A CONTRACT DOCUMENT. 4. THIS DRAWING IS FOR INFORMATION PURPOSES ONLY AND IS NOT A CONTRACT DOCUMENT. 5. THIS DRAWING IS FOR INFORMATION PURPOSES ONLY AND IS NOT A CONTRACT DOCUMENT. 6. THIS DRAWING IS FOR INFORMATION PURPOSES ONLY AND IS NOT A CONTRACT DOCUMENT. 7. THIS DRAWING IS FOR INFORMATION PURPOSES ONLY AND IS NOT A CONTRACT DOCUMENT. 8. THIS DRAWING IS FOR INFORMATION PURPOSES ONLY AND IS NOT A CONTRACT DOCUMENT. 9. THIS DRAWING IS FOR INFORMATION PURPOSES ONLY AND IS NOT A CONTRACT DOCUMENT. 10. THIS DRAWING IS FOR INFORMATION PURPOSES ONLY AND IS NOT A CONTRACT DOCUMENT.

<p>McFarland Johnson 60 RAILROAD PLACE SUITE 402 SAINT PAUL, MINNESOTA 55102-2026 (651) 222-5545 Santogiovanni@jplinc.com</p> <p>PROJECT NUMBER: PERMIT SKETCHES</p> <p>NO. DATE DESCRIPTION</p> <p>1</p> <p>2</p> <p>3</p> <p>4</p> <p>5</p> <p>6</p> <p>7</p> <p>8</p> <p>9</p> <p>10</p> <p>11</p> <p>12</p> <p>13</p> <p>14</p> <p>15</p> <p>16</p> <p>17</p> <p>18</p> <p>19</p> <p>20</p> <p>21</p> <p>22</p> <p>23</p> <p>24</p> <p>25</p>	
<p>CLIENT: ALBANY PORT DISTRICT COMMISSION ALBANY, NEW YORK</p> <p>PROJECT: PORT OF ALBANY EXPANSION SITE</p>	
<p>SECTION J-J Horizontal Scale: 1" = 10' Vertical Scale: 1" = 10'</p>	
<p>SECTION K-K Horizontal Scale: 1" = 10' Vertical Scale: 1" = 10'</p>	
<p>DRAWING NUMBER: XS-02 PAGE OF SHEET</p> <p>SECTION VIEWS</p> <p>1. A SECTION LINE FOR ANY POINT, LINES NOT SHOWN ARE HORIZONTAL. 2. ALL DIMENSIONS ARE IN FEET. 3. ALL ELEVATIONS ARE IN FEET. 4. ALL DEPTHS ARE IN FEET. 5. ALL SLOPES ARE IN FEET. 6. ALL RADII ARE IN FEET. 7. ALL LENGTHS ARE IN FEET. 8. ALL AREAS ARE IN SQUARE FEET. 9. ALL VOLUMES ARE IN CUBIC FEET. 10. ALL ANGLES ARE IN DEGREES. 11. ALL COORDINATES ARE IN FEET. 12. ALL COORDINATES ARE IN FEET. 13. ALL COORDINATES ARE IN FEET. 14. ALL COORDINATES ARE IN FEET. 15. ALL COORDINATES ARE IN FEET. 16. ALL COORDINATES ARE IN FEET. 17. ALL COORDINATES ARE IN FEET. 18. ALL COORDINATES ARE IN FEET. 19. ALL COORDINATES ARE IN FEET. 20. ALL COORDINATES ARE IN FEET. 21. ALL COORDINATES ARE IN FEET. 22. ALL COORDINATES ARE IN FEET. 23. ALL COORDINATES ARE IN FEET. 24. ALL COORDINATES ARE IN FEET. 25. ALL COORDINATES ARE IN FEET.</p> <p>DRAWING TITLE: WASTE WATER TREATMENT PLANT OUTFALL (K-K)</p>	

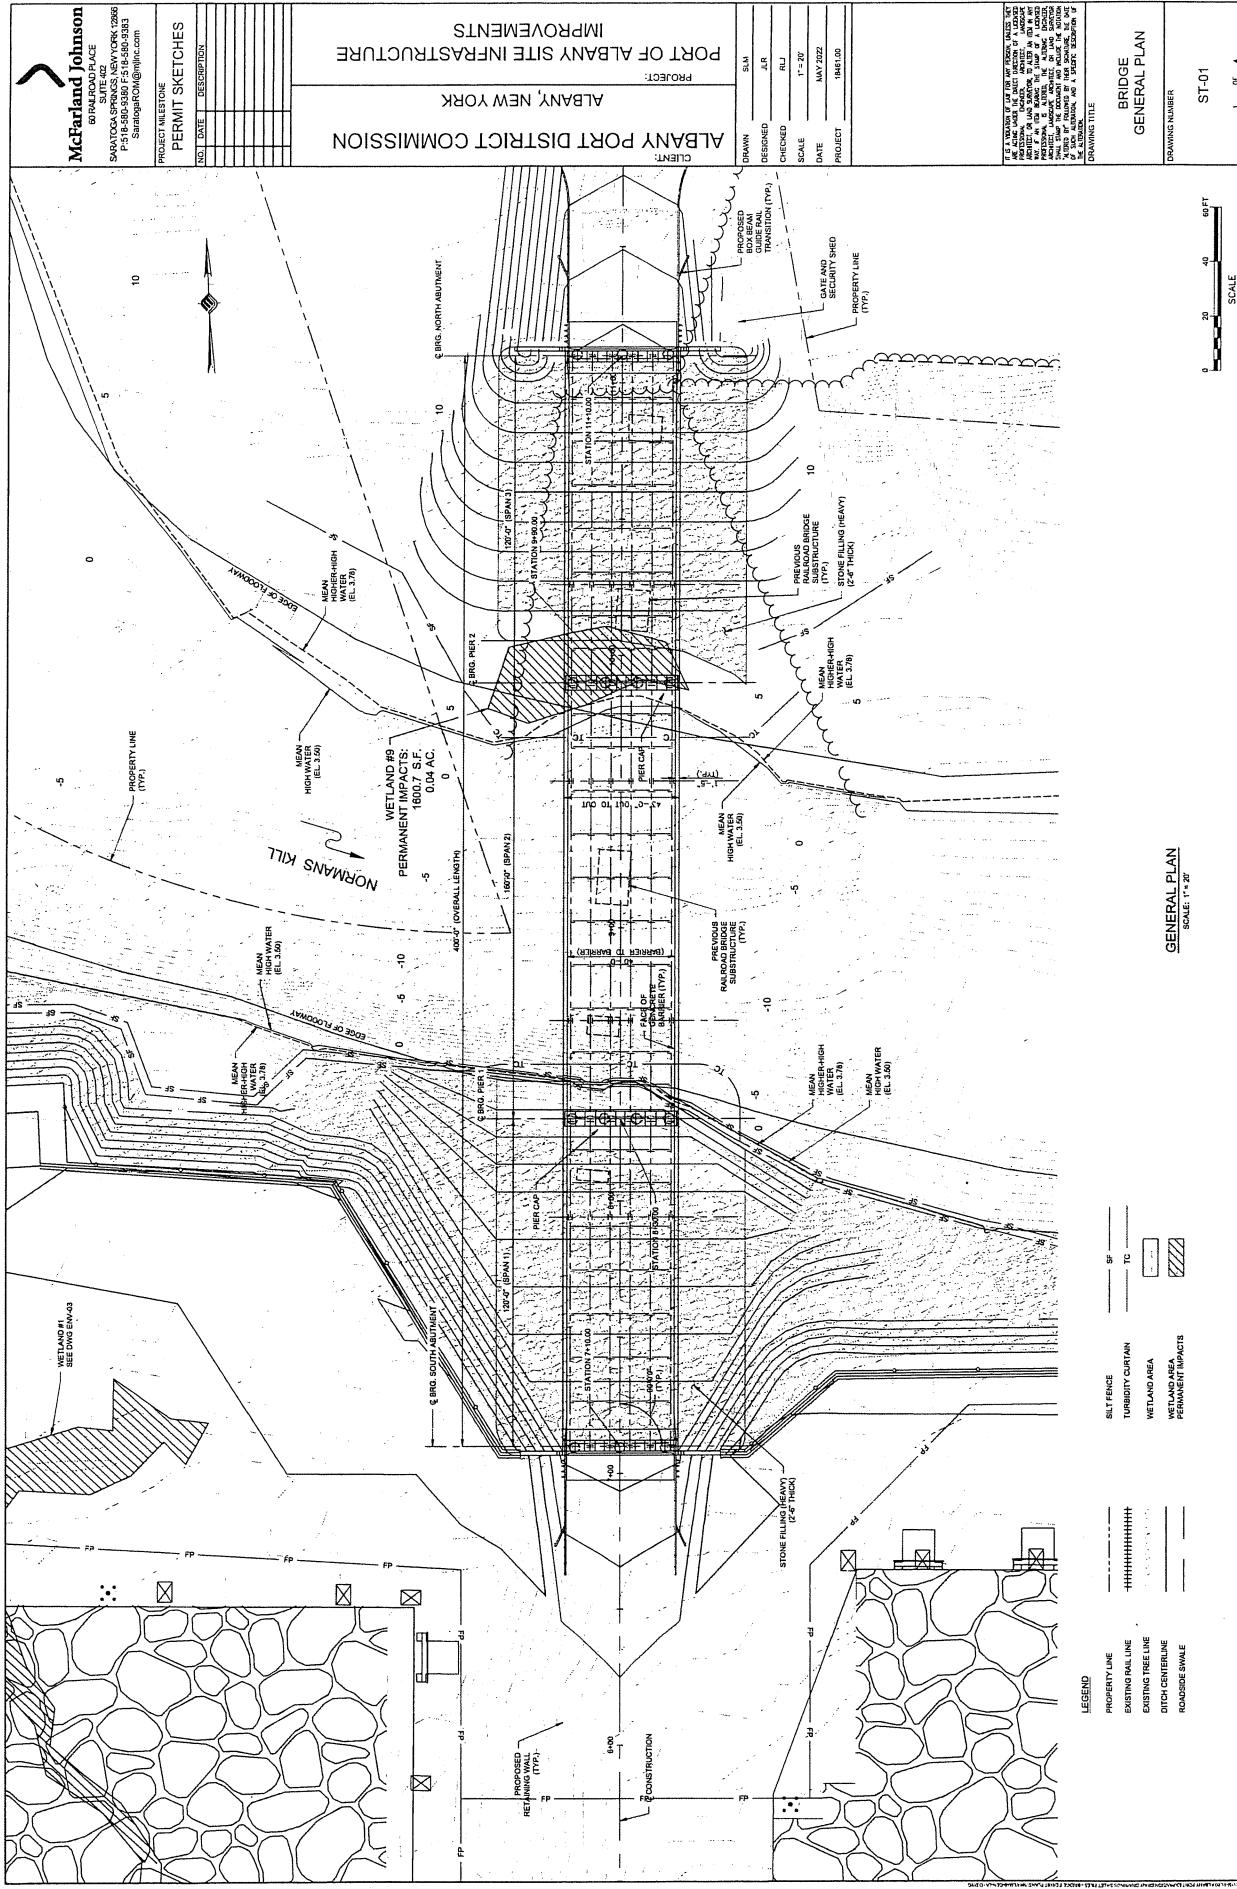

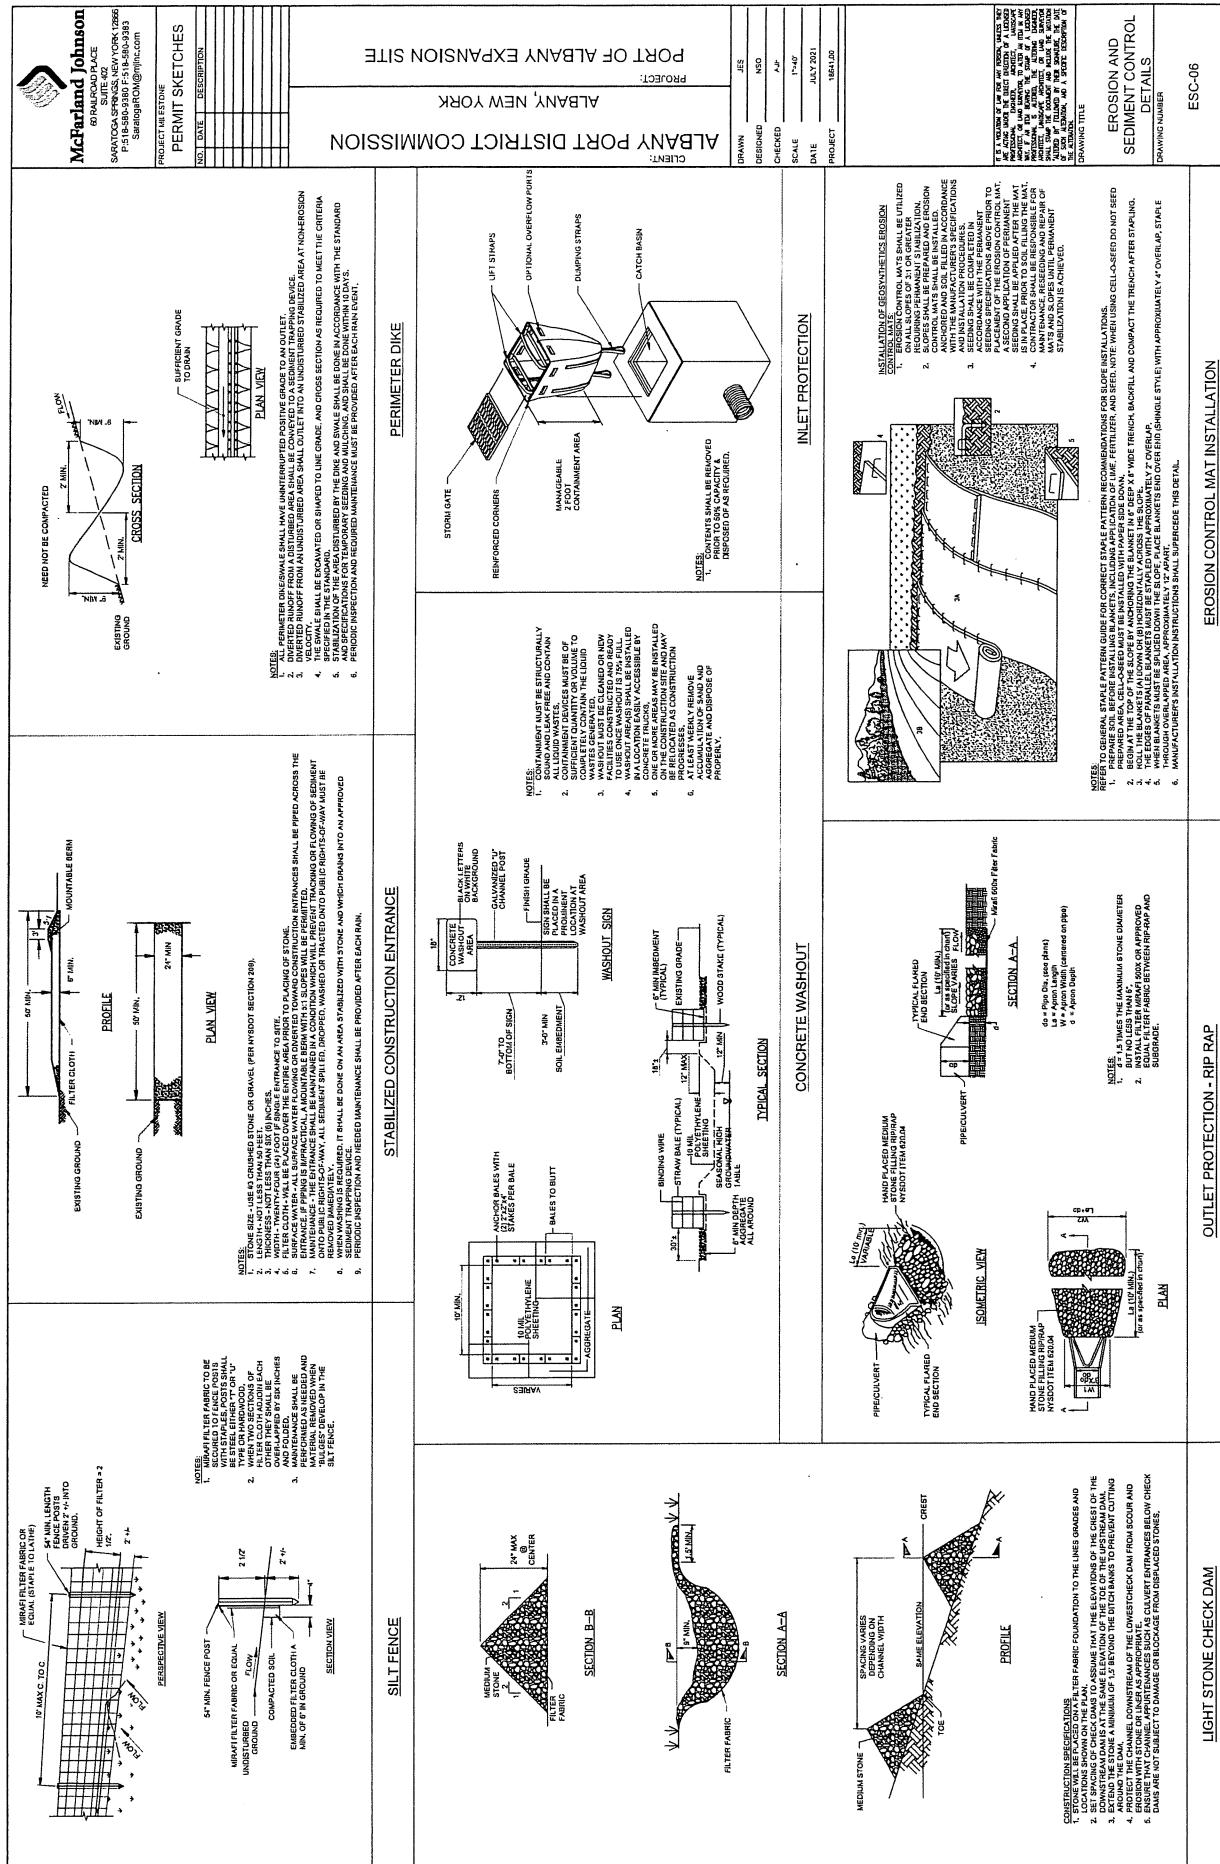

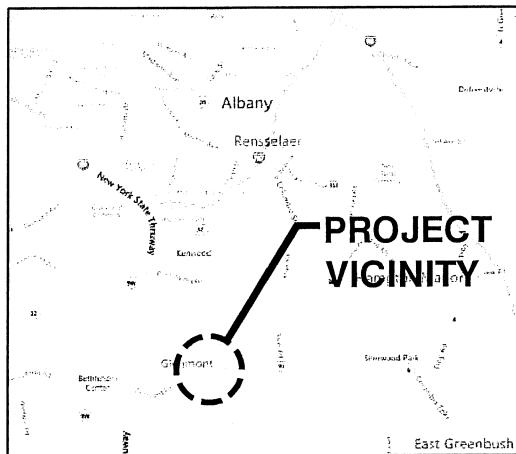

VICINITY AND LOCATION MAP

SCALE: N.T.S.

NOTES:

1. HORIZONTAL CONTROL REFERENCED TO NORTH AMERICAN DATUM OF 1983, STATE PLANE COORDINATE SYSTEM, NEW YORK, EAST ZONE, IN FEET.
2. WATER LEVEL DATUM IS BASED ON NATIONAL GEODETIC VERTICAL DATUM OF 1929, AS FOLLOWS:
 - MEAN HIGHER HIGH WATER LEVEL (MHHW) +4.56 FT (NGVD29)
 - MEAN HIGH WATER LEVEL (MHW) = +4.18 FT (NGVD29)
 - MEAN TIDE LEVEL (MTL) = +1.69 FT (NGVD29)
 - MEAN LOW WATER LEVEL (MLW) = -0.80 FT (NGVD29)

PURPOSE: WHARF CONSTRUCTION
PERMIT SUBMITTAL-NOT TO BE USED
FOR CONSTRUCTION
DATUM: NGVD29



m & n engineering, p.c.


OWNER/APPLICANT:
ALBANY PORT DISTRICT COMMISSION
PORT OF ALBANY

IN: HUDSON RIVER
NEAR: SOUTH OF ALBANY
LOCATION: PORT OF ALBANY
106 SMITH BOULEVARD
ALBANY, NEW YORK 12202

WHARF DREDGING AND CONSTRUCTION

VICINITY AND LOCATION

DATE: 2021-07-15

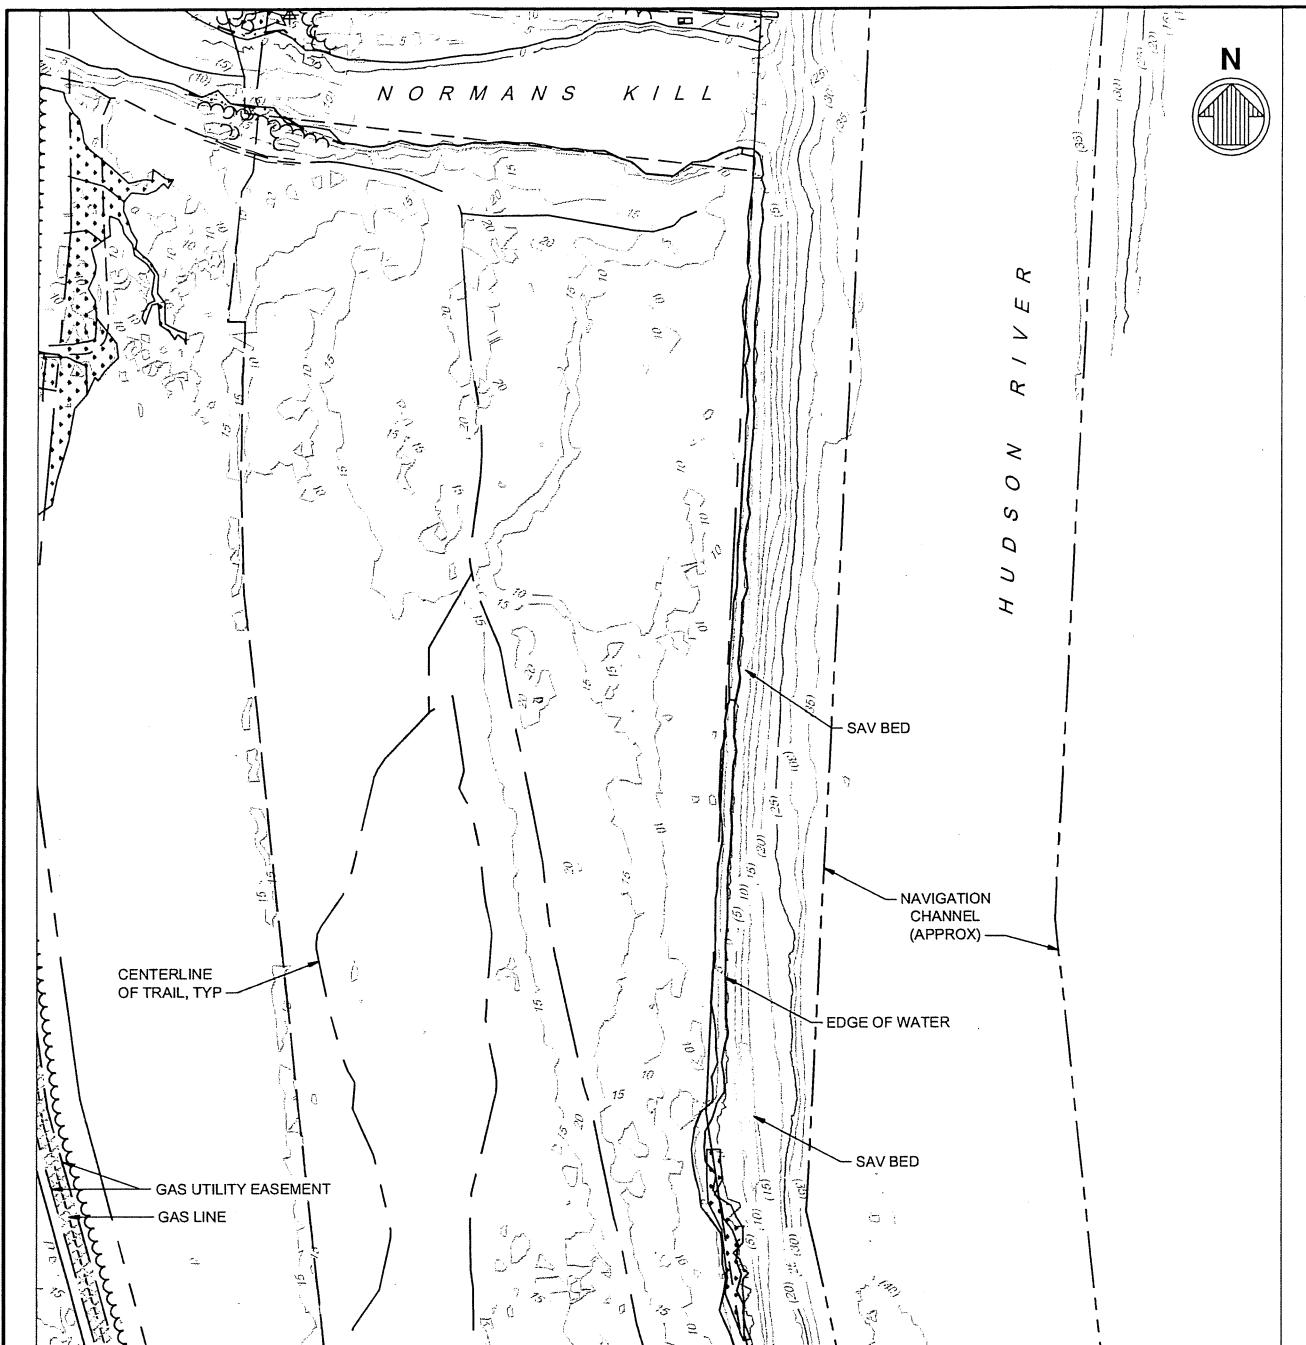

PLAN - EXISTING CONDITIONS

150' 0' 150' 300'

SCALE: 1"=300'

PURPOSE: WHARF CONSTRUCTION
PERMIT SUBMITTAL-NOT TO BE USED
FOR CONSTRUCTION
DATUM: NGVD29



m&n engineering, p.c.


OWNER/APPLICANT:
ALBANY PORT DISTRICT COMMISSION
PORT OF ALBANY


IN: NEAR: HUDSON RIVER
LOCATION: SOUTH OF ALBANY
PORT OF ALBANY
106 SMITH BOULEVARD
ALBANY, NEW YORK 12202

WHARF DREDGING AND CONSTRUCTION

PLAN - EXISTING CONDITIONS

DATE: 2021-07-15

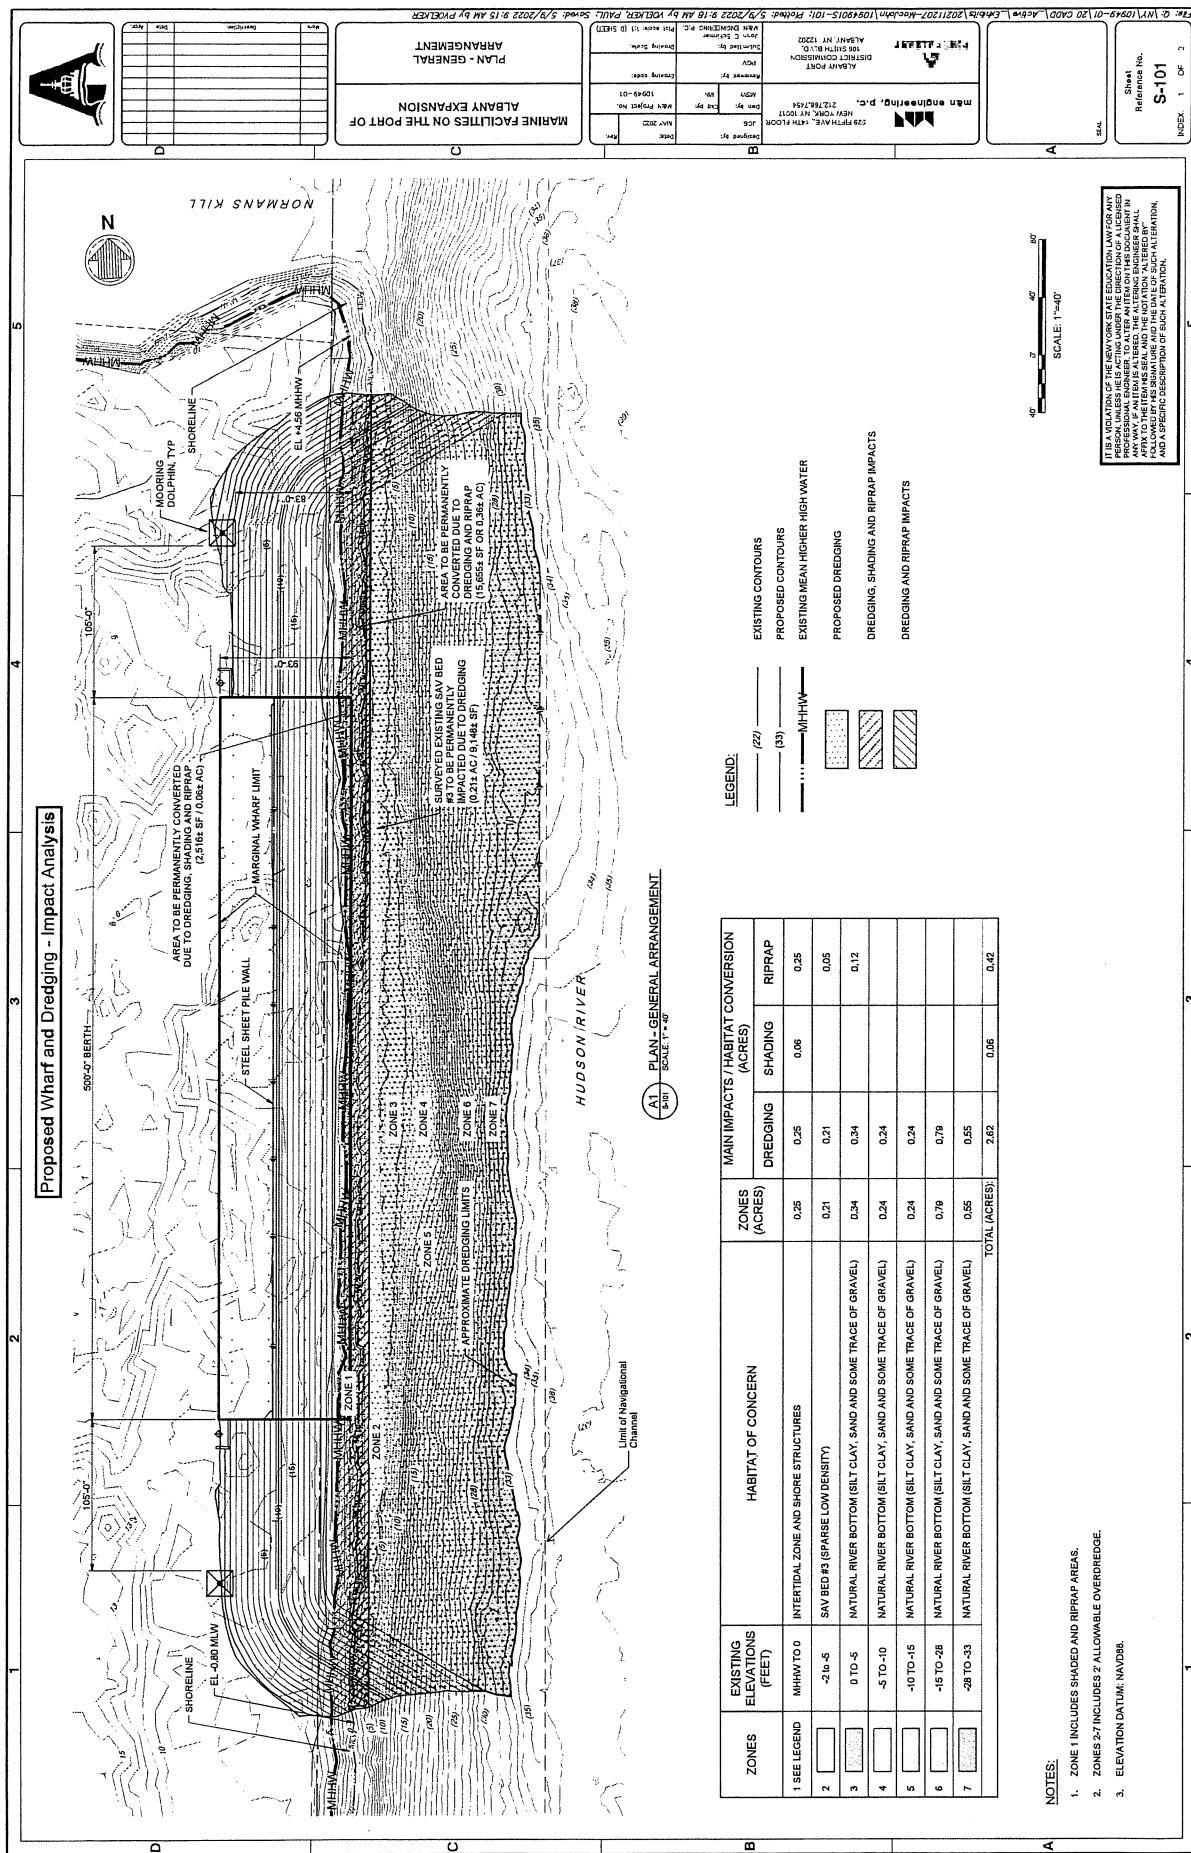

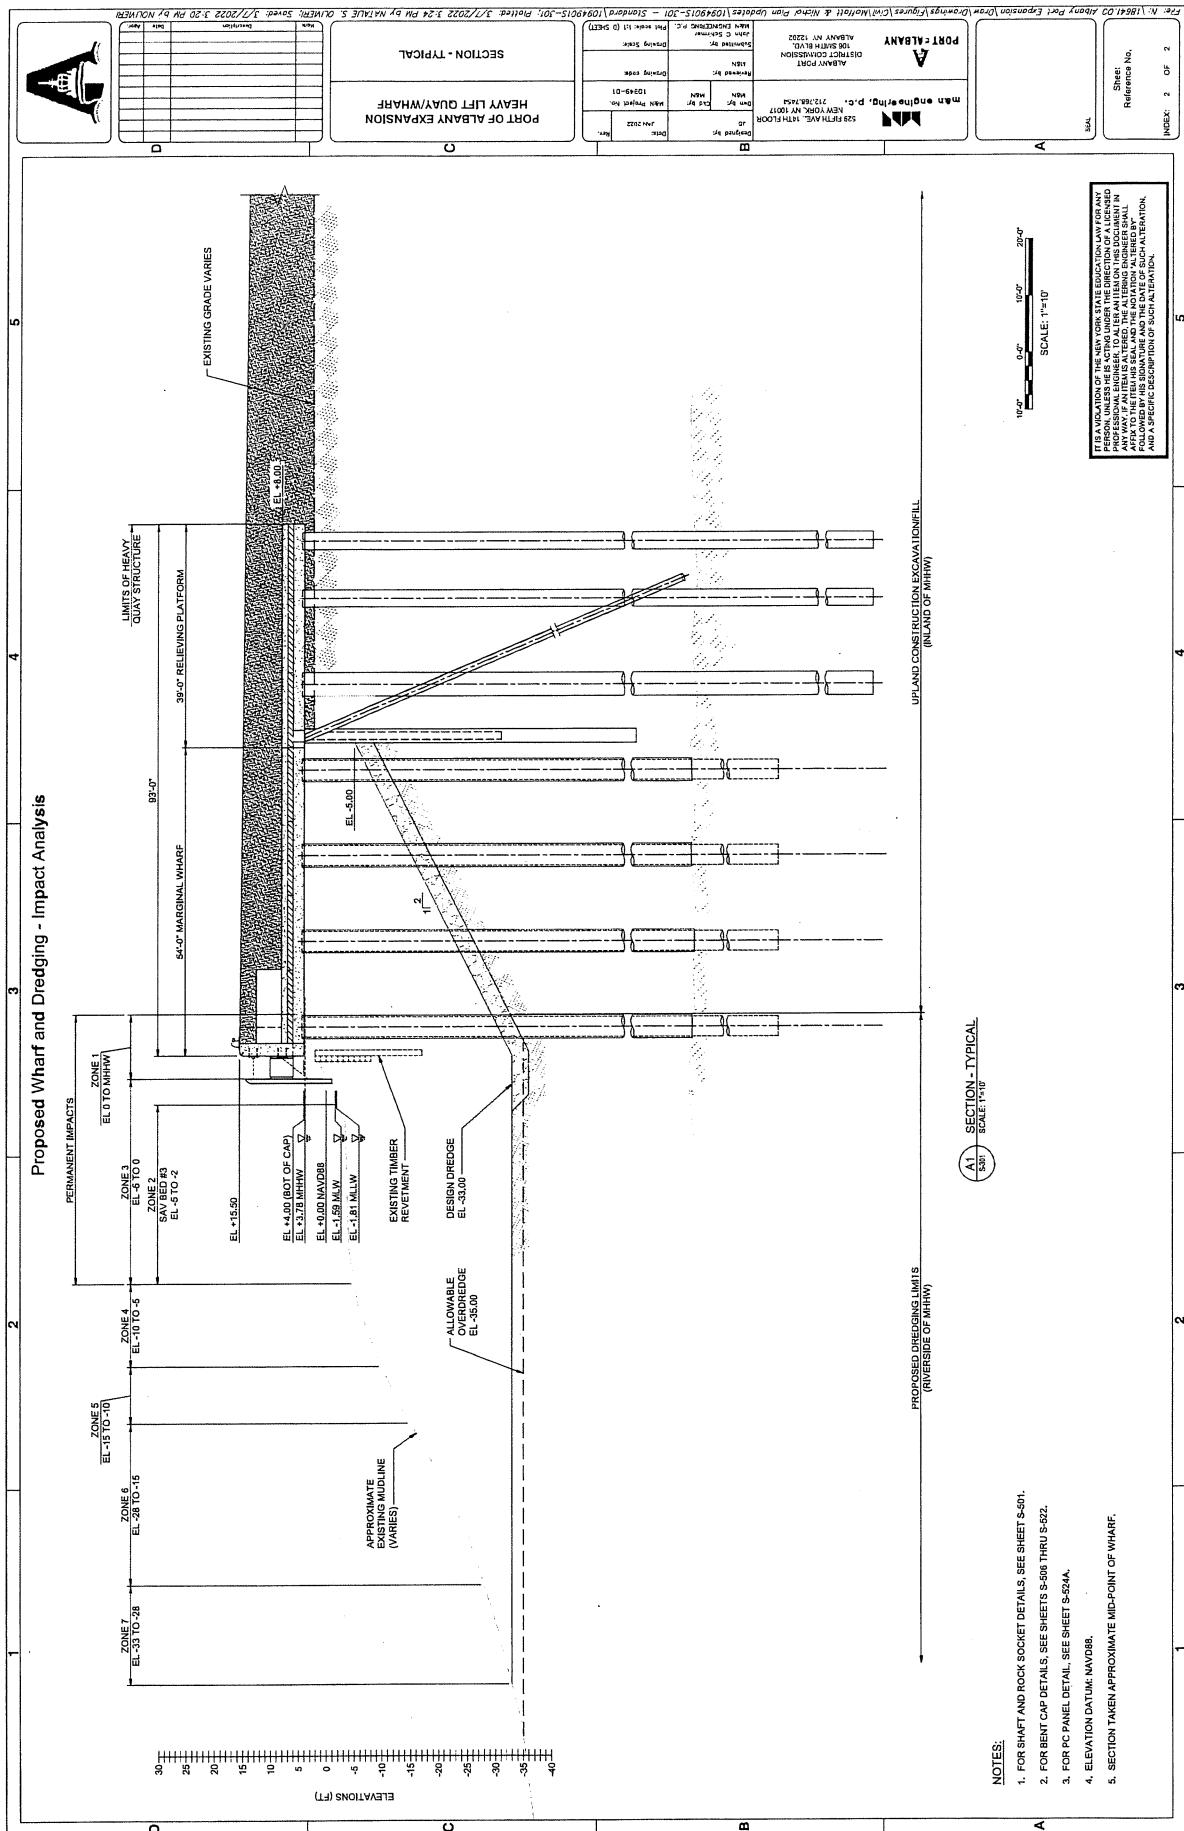

Albany Port District Commission

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